

Arthur Ashe Charter School 1456 Gardena Dr.

Project location Arthur Ashe Charter School 1456 Gardena Dr., New Orleans, Louisiana

Contact Information

Facilities Supervisor: Aaron Michalski 504-717-3401

Ashe School Principals: Sivi Domango 504-421-2162

Project Landscape Architect:
Terry Ibert
o.504-522-5444 c.504-715-2013
3027 Ponce de Leon St.
New Orleans, La. 70119

contractor notes

- *Contractor responsible to call Louisiana one-call and have utility lines marked before any excavation 1-800-272-3020 / www.laonecall.com
- *Any permits or municipal requirements to complete this work are the responsibility of the contractor.
- *Contractor responsible to have utility lines located and marked wherever they may be affected by this project.
- *Contractor to notify all listed parties 48 hours before commencement of work.
- *Contractor to coordinate with and accommodate needs of Ashe school principal and facilities manager prior to any interruption of water service to school.
- *All areas excavated or disturbed by the construction process will be back filled, fine graded and returned to the original grade.
- *Contractor to remove and safely dispose of all construction debris generated by their work.
- *Glue joints on all electrical conduit, cap and mark ends of all unused conduit w/ 2x4 stakes.

drawing notes

- *irrigation model and product numbers are based on Rain Bird Irrigation Products 2013 catalog
- *irrigation main water line is 2" sch. 40 pvc pipe to be set min. 18" deep
- *lateral line sizes are indicated on drawings, all laterals sch. 40 pvc set min. 8" deep.
- *valve locations are indicated on the site plan.
- *active valves are indicated by valve product # and type.
- *a 6" stub w/ cap is to T off of the main line @ each inactive valve location.
- *all valve locations are to be installed in a VB-STD 21.8"x16.6" valve box, a 36" loop of irrigation controller wire is to be coiled in each box.

bid noted 3 strand / 18 guage irrigation controllr wire throught the irrigation system.

- *This bid is for the installation of the 2" irrigation main line, 2" PVB and connection with 2" shut off valve to the existing 2" stub out on the buildings main water line.
- *Installation of irrigation zones A-1/A-2/A-3/A-4/A-5.
- *Installation and activation of controller A and all accessory components.
- *Installation and activation of controller B and all accessory components.
- *Connection of zone B-1 to the 3 existing irrigation zones at the school entrance.
- *Installation of 1-1/2" sch. 80 electrical conduit under emergency driveway from 3' on building side of driveway to greenhouse location.
- *Installation of all conduit and pipe crossings under driveways and walkways as indicated on plans.

Drawing Index

page 1: Cover Page

page 2: Site Plan Production Area

page 3: Irrigation Plan / Main Line & Valve Location

page 4: Irrigation Plan / Zones A-1/A-2/A-3/A--4

page 5: Irrigation Plan / Zones A-5/A-6

Terry Ibert

3027 Ponce de Leon St. New Orleans, La. &0119 504-522-5444 Landscape Architecture

Ashe School Edible School Yard Page 6: Virigation Details

1456 Gardena Drive
New Orleans, La.


Cover Page


drawn:
Terry Ibert
date:
2/5/2013
scale:

revision:

1

6

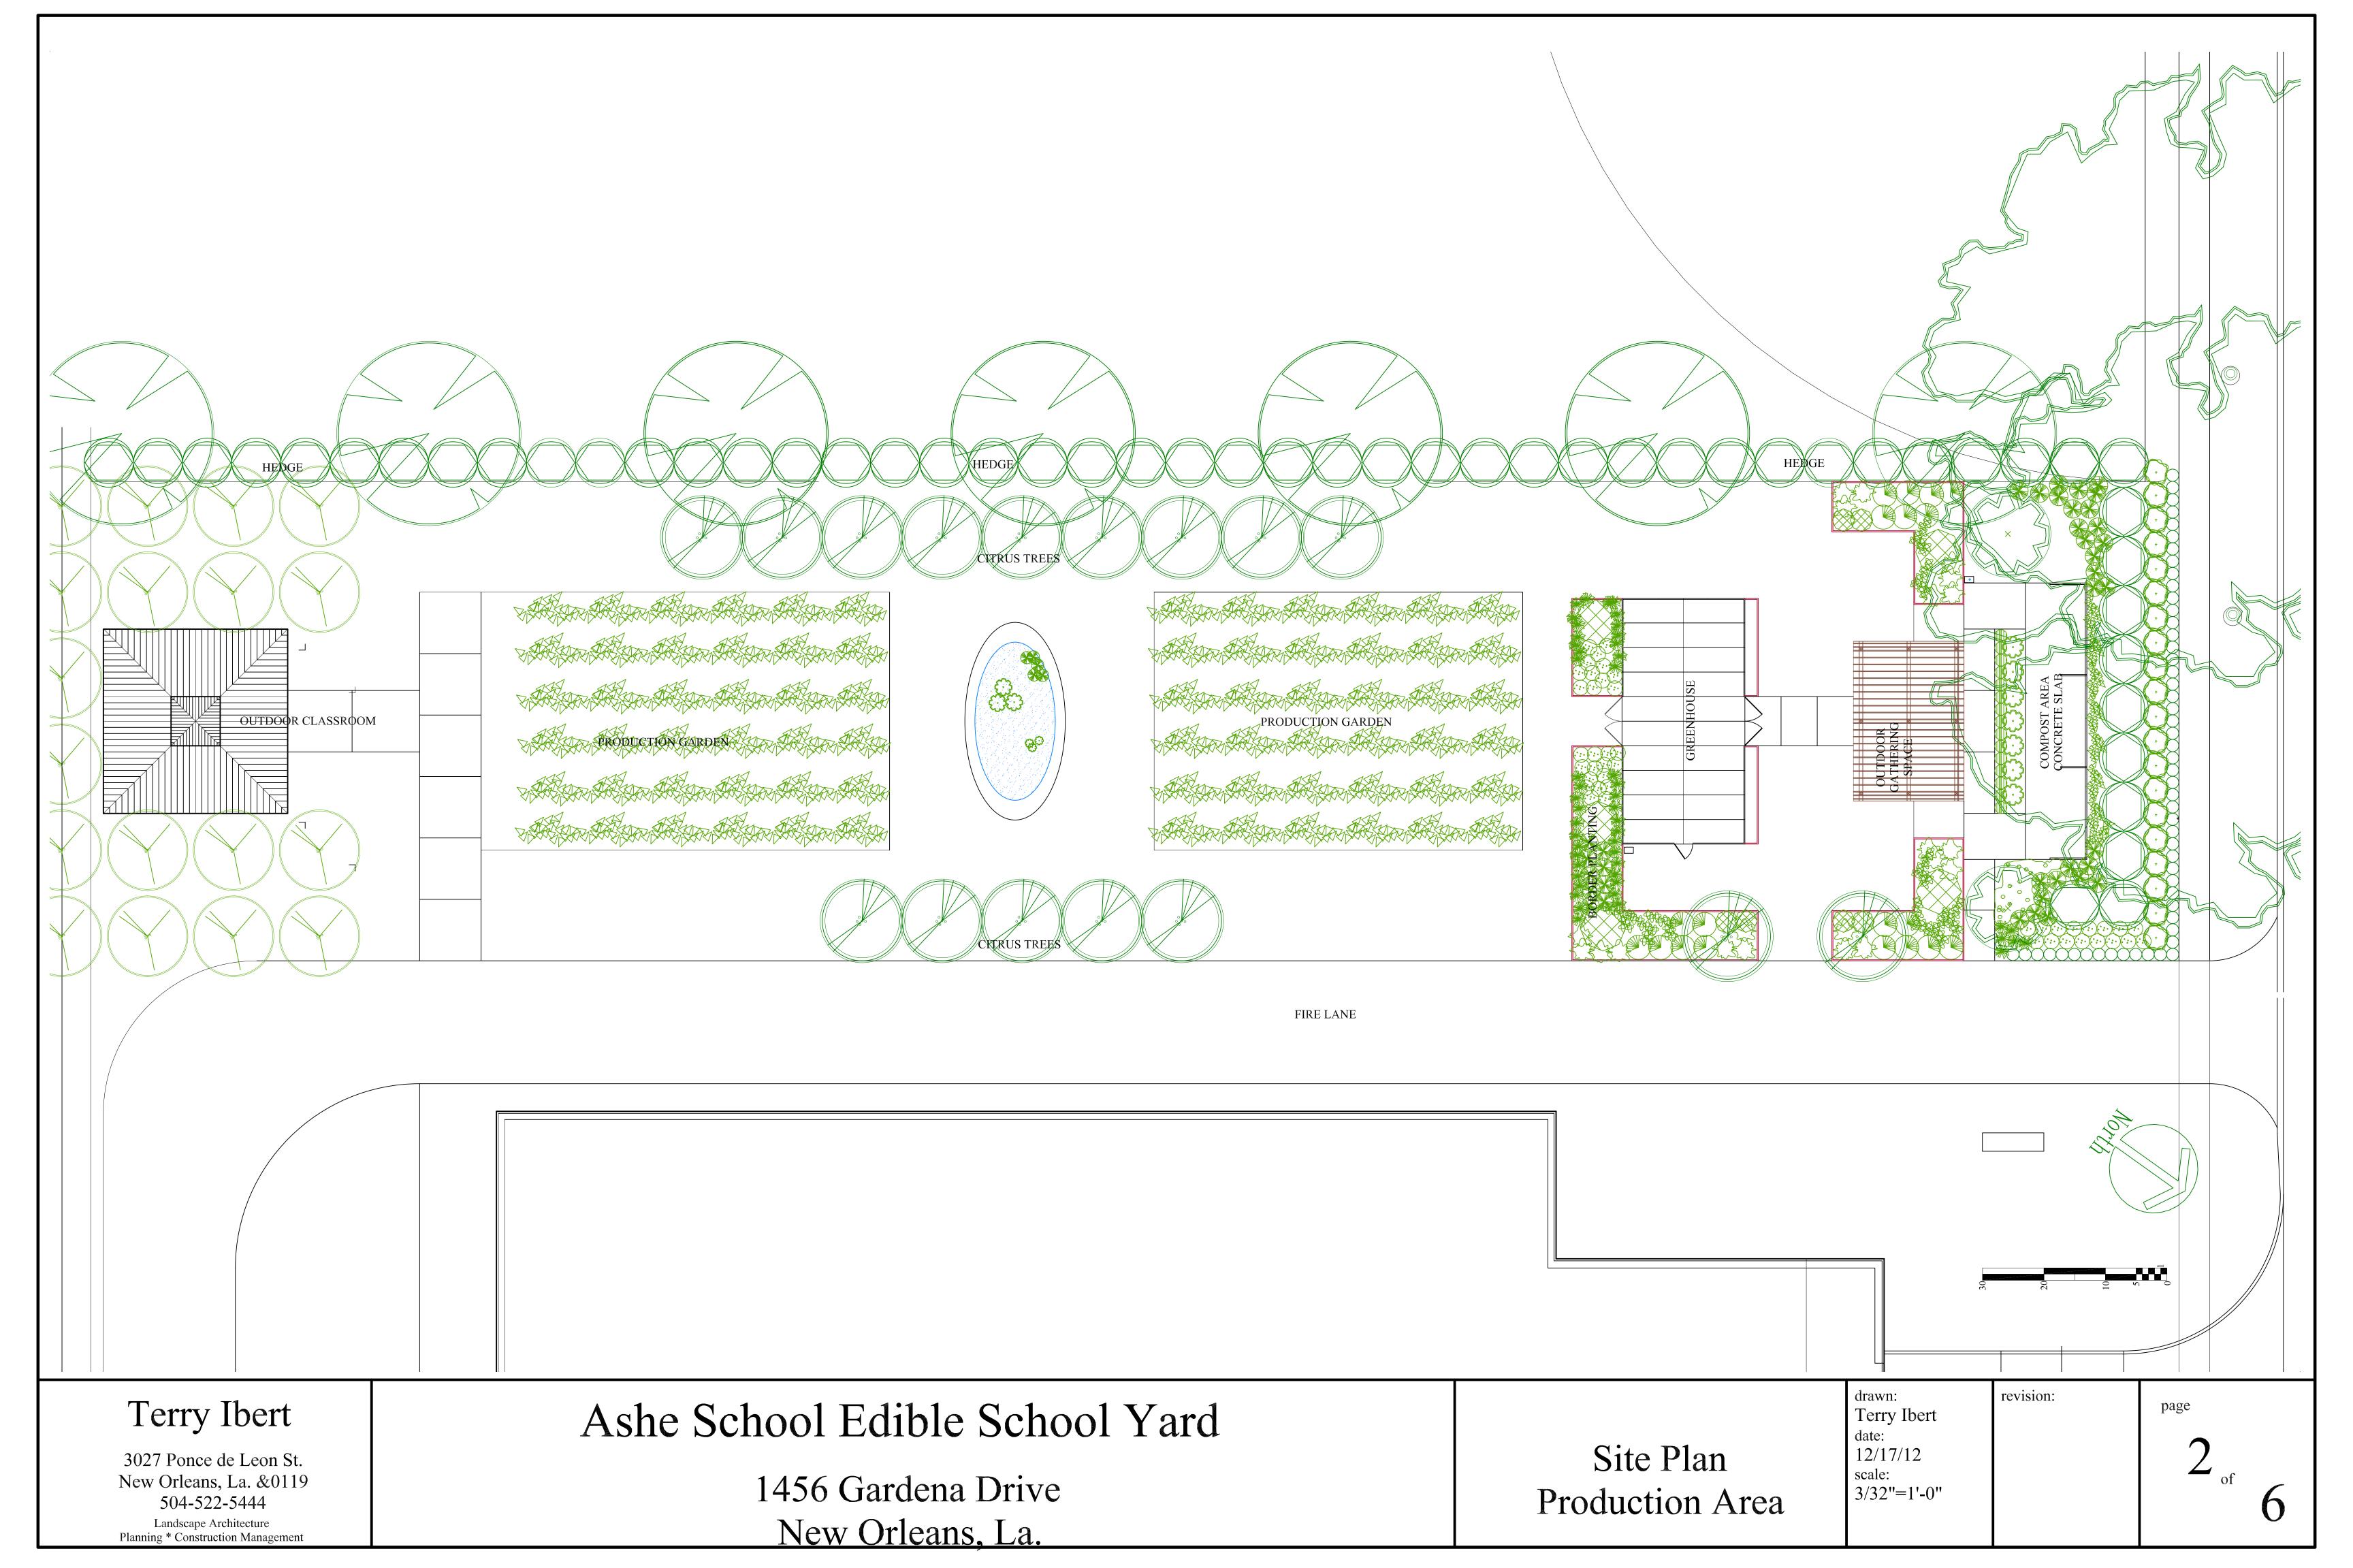


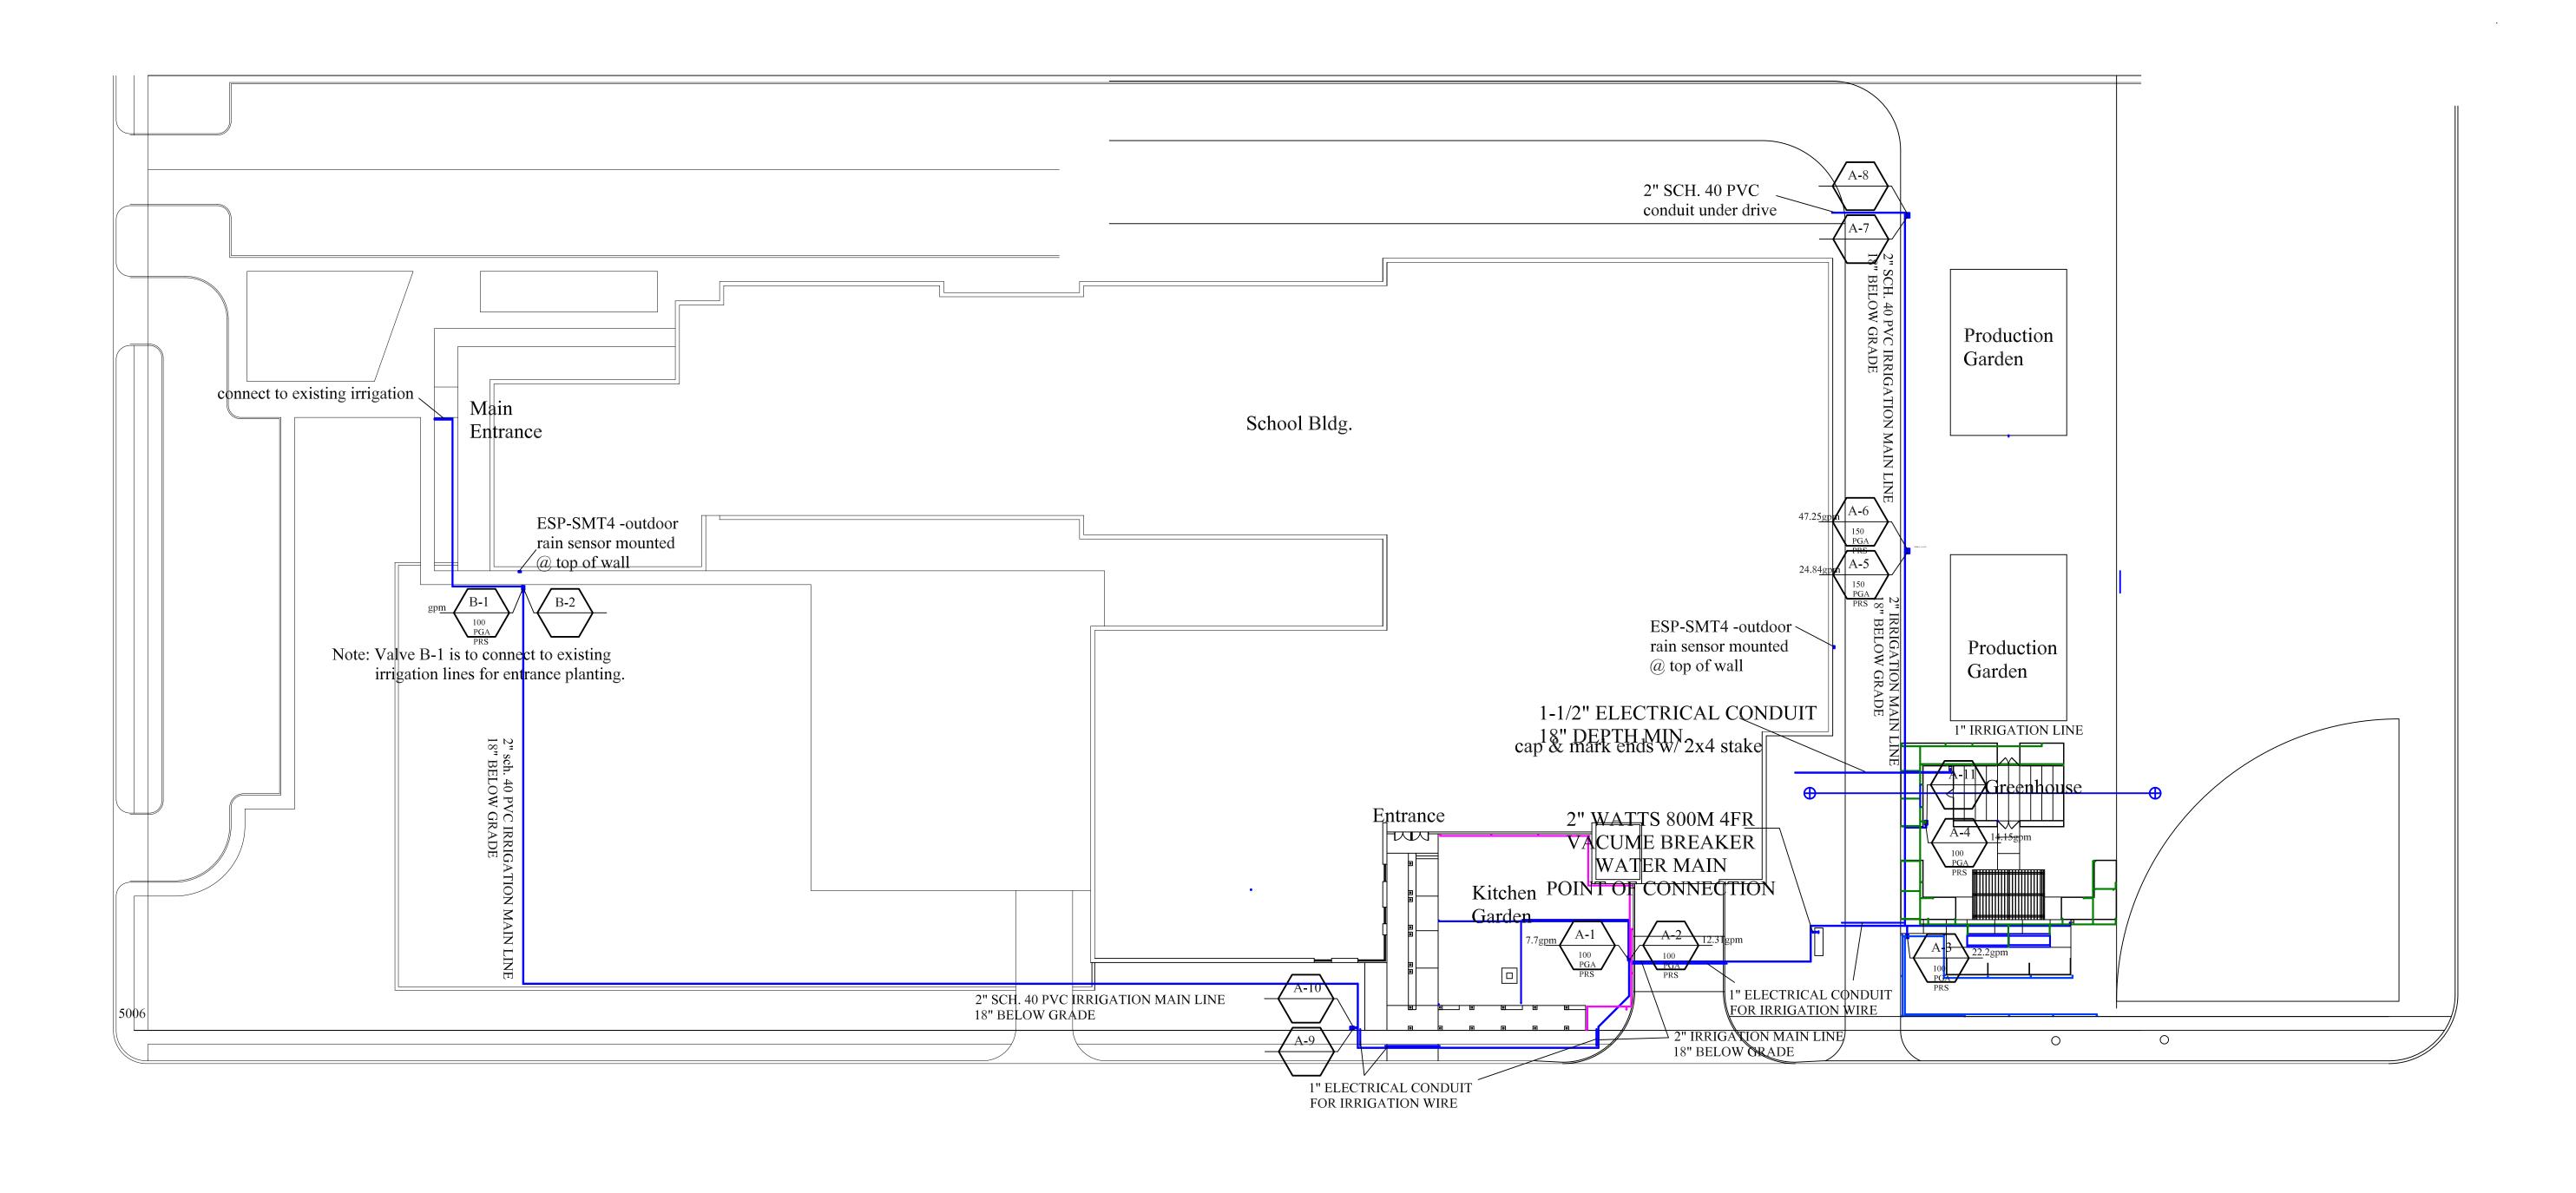

Note:

Irrigation valve, rotor, popup and nozzle model # refer to Rain Bird irrigation products. Protect all exposed pipe with cold wheather insulation.

Use 13 strand / 18 guage irrigation controller /valv wire. Install 2" brass shut off valve and 2" Watts PVB on 2" copper pipe at point of connection.

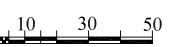

scale: 1"=30'-0"

Terry Ibert

3027 Ponce de Leon St. New Orleans, La. &0119 504-522-5444 Landscape Architecture

Planning * Construction Management

Ashe School Edible School Yard

1456 Gardena Drive New Orleans, La.

Irrigation Plan Main Line & Valve Location

awn:	
erry Ibert	
te:	
10/13	
ale:	
'=30'-0"	

revision:

3

page

6

